

MASON PLAN 2330

MASON Plan 2330



Plan Schedule

03-12-2019 Floor Plan Review
Bid Set
Full CD's

Final Drawings

S. Q. FOOTAGES

Main Level

2330 SQ. FT.

Front Porch Covered Patio Uncovered Patio

120 SQ. FT. 180 SQ. FT. 85 SQ. FT.

555 SQ. FT. Garage

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A4.0 Foundation Details
A4.1 Standard Framing Details
A4.2 Framing Details
E1.0 Main Level Electrical Plan
E1.1 Upper Level Electrical Plan

SHEET NUMBER


Cover Page

General Notes:

- 1. Do not scale drawings. If dimensions are in question, obtain clarification from the Owner before continuing with construction. All dimensions relating to existing conditions shall be field verified.
- 2. All structural details and callouts are given as general information and should be verified by locale engineer. While constructing this project all Locale, Start and Federal codes that apply should be applied. By building this project you agree not to hold the designer or any party associated with them accountable for damages, lost of revenue or anything else associated with this project.
- 3. Dimensions are called out from outside face of studs @ exterior walls to centerline of interior stud walls. Window and door opening, in stud construction, are dimensioned to center of opening. Masonry walls are called out from out side face of masonry to face of masonry. Window and door opening, in masonry construction, are dimensioned as masonry openings (noted as M.O.).
- 4. Dimensions for elevations, sections, and details are called out from top of sub floor.
- 5. Any dimensional discrepancies are to be directed to the Owner, before fabrication of area in question.
- 6. Contractor to field verify all existing conditions and dimensions. Contractor to notify Owner of any discrepancies with these drawings and/or site information prior to beginning construction and/or ordering materials.
- 7. Contractor to provide wood blocking for all millwork and any wall hung counters, ledges and shelving. Provide blocking as required by construction.
- 8. All finish work shall be smooth, free from abrasion and/or tool marks on any exposed surfaces. All specified finishes are to be installed per manufacturers instructions.
- 9. All construction shall comply with all building codes and requirements having jurisdiction over this project.
- 10. Verify with Owner reflected ceiling plan intent, the placement in relation to adjacent finishes or grids. Contractor to coordinate owner review meeting to approve all power and telephone outlet locations. This meeting shall be after all walls have been framed and before any wall finishes have been applied. Modify electrical as required to accommodate any owner selected fixtures / appliances. Notify Owner of any revisions.
- 11. Piping located above grade and inside the building shall be concealed in chases/furred spaces with the exception of piping in equipment rooms. The contractor shall coordinate with other trades to provide furring for piping installed in finish areas.
- 12. All door frame locations are to be determined by: inside face of doorframe will be located minimum 4" clear from the edge of the adjacent partition, unless noted otherwise. For CMU walls see dimensional plan.
- 13. Contractor to coordinate keying requirements with owner (master keying, grandmaster keying, etc.)
- 14. Contractor to verify location of electrical floor outlets, telephone receptacles, and cable connections with Owner prior to installation.
- 15. Contractor to verify location of thermostats, Air handlers, and condensing units with Owner prior to installation. All ductwork is to be concealed unless otherwise noted.
- 16. Beams, Headers, Footings, Foundation Walls and Lentils to be sized by an engineer or manufacturer.
- 17. Use double joists under walls, which run parallel to joists.
- 18. Exact size and reinforcement of all concrete footings must be determined by local soil conditions and acceptable practices of construction. Verifying design with local Geotech Engineer.
- 18. Electrical Contractor to verify and/or size electrical system to meet or exceed local code requirements.
- 20. H.V.A.C. Contractor to verify and/or size heating and cooling loads for local codes, climatic conditions and building orientation, and volume of interior space.
- 21. Plumbing Contractor: plumbing materials and installation to be done in accordance with local requirements.
- 22. Windows designations are provided as the outer sash dimensions of the unit, and called out in feet and inches wide by feet and inches tall. (Example; 2852 designation is a window with a 2 foot 8 inch wide by 5 foot 2 inch tall sash.) Contractor to coordinate sill extensions as required for exterior wall conditions.
- 23. Builder to have braced walls and shear walls designed by others. Designer is not responsible for designing braced walls.

ALTERNATE PRICING REQUEST

1. 2. 3. 4. 5. 6. 7. 8. 9. 10. 11.

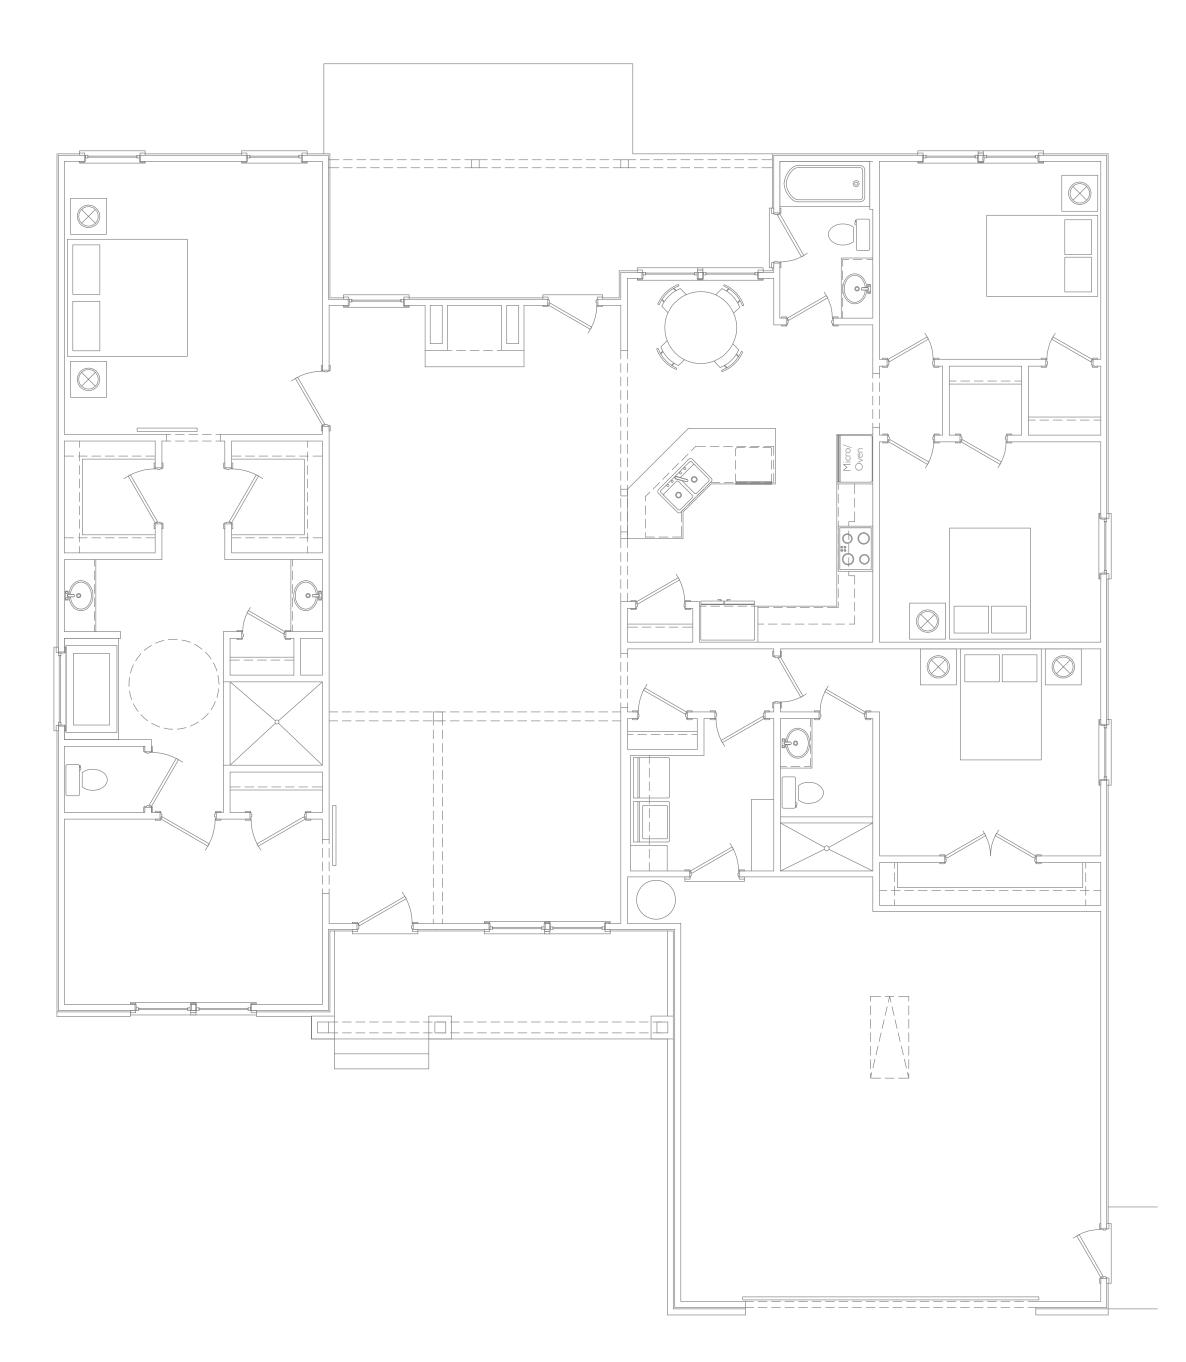

MAIN LEVEL SQ FOOTAGE

3/16" = 1'-0" SCALE

MASON

Plan 2330



HOMES

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S. Q. FOOTAGES

Main Level 2330 SQ. FT.

Front Porch
Covered Patio
Uncovered Patio

Garage 555 SQ. FT.

120 SQ. FT.

180 SQ. FT.

85 SQ. FT.

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A4.1 Standard Framing D


A4.1 Standard Framing DetailsA4.2 Framing Details

E1.0 Main Level Electrical Plan
E1.1 Upper Level Electrical Plan

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General Notes

T1.1

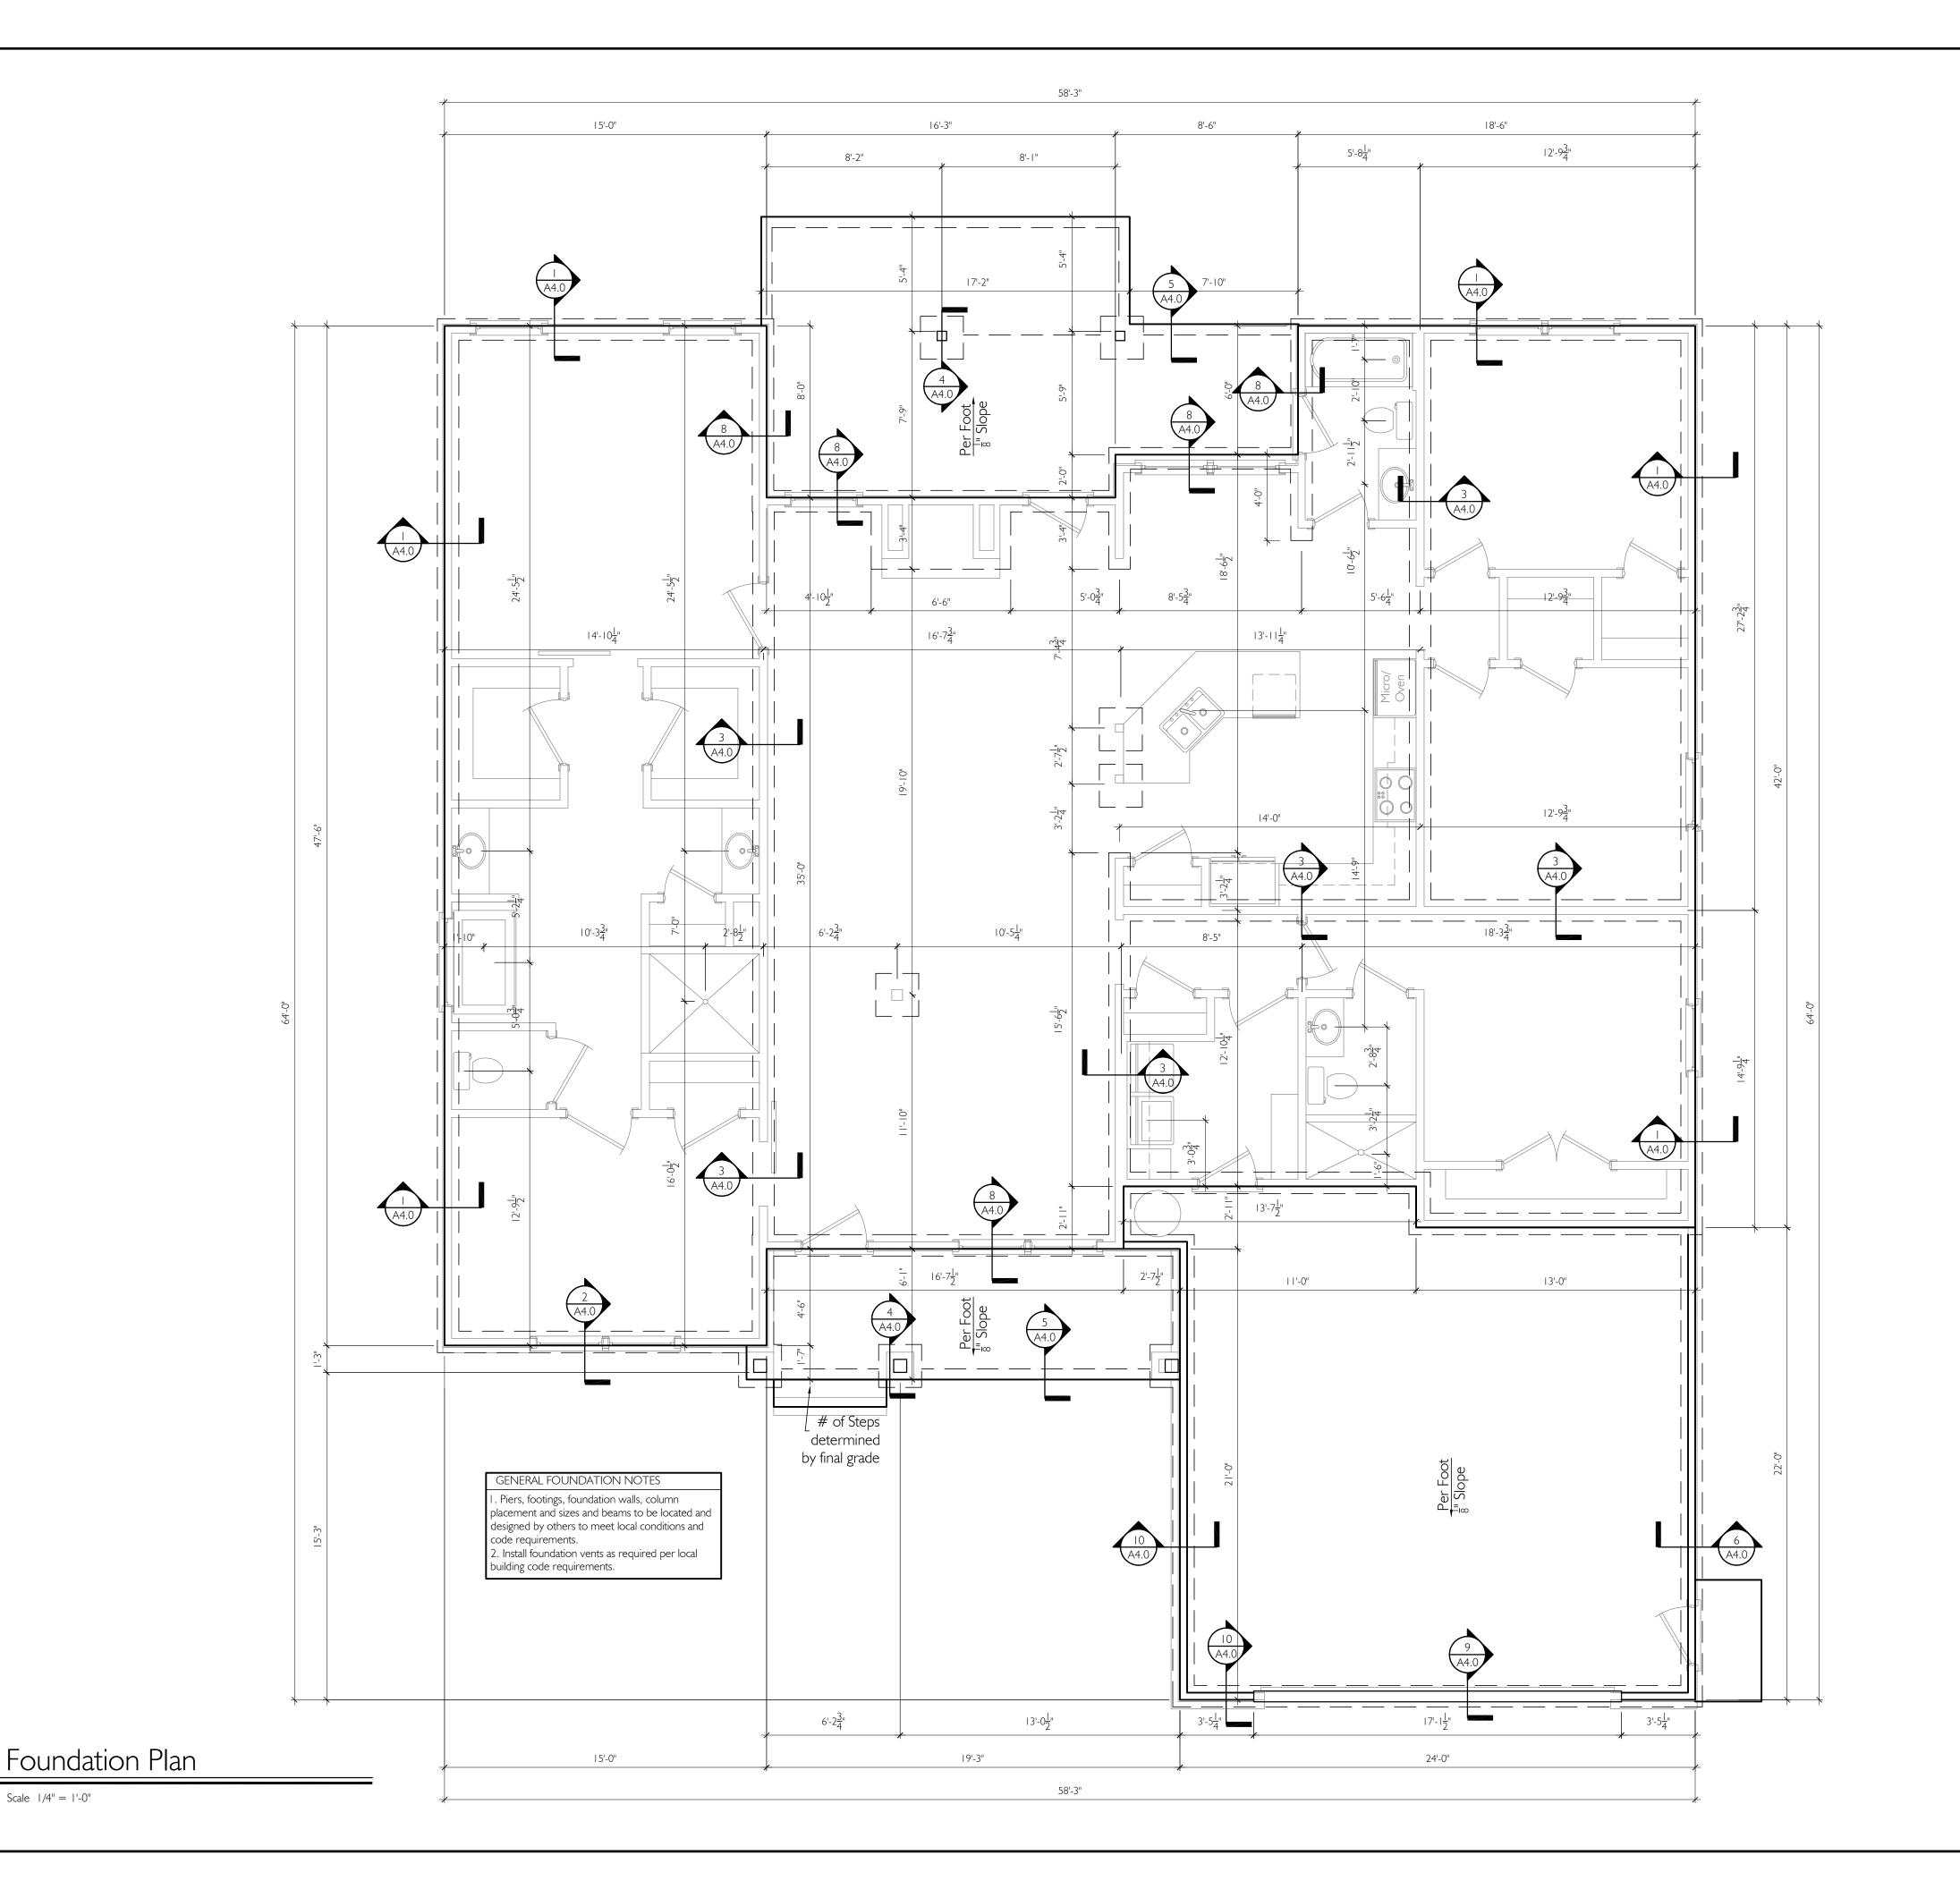

MASON Plan 2330



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S.Q. FOOTAGES Main Level 2330 SQ. FT.


120 SQ. FT. 180 SQ. FT. Front Porch Covered Patio 85 SQ. FT. Uncovered Patio

Garage 555 SQ. FT.

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SHEET NUMBER
Foundation Plan



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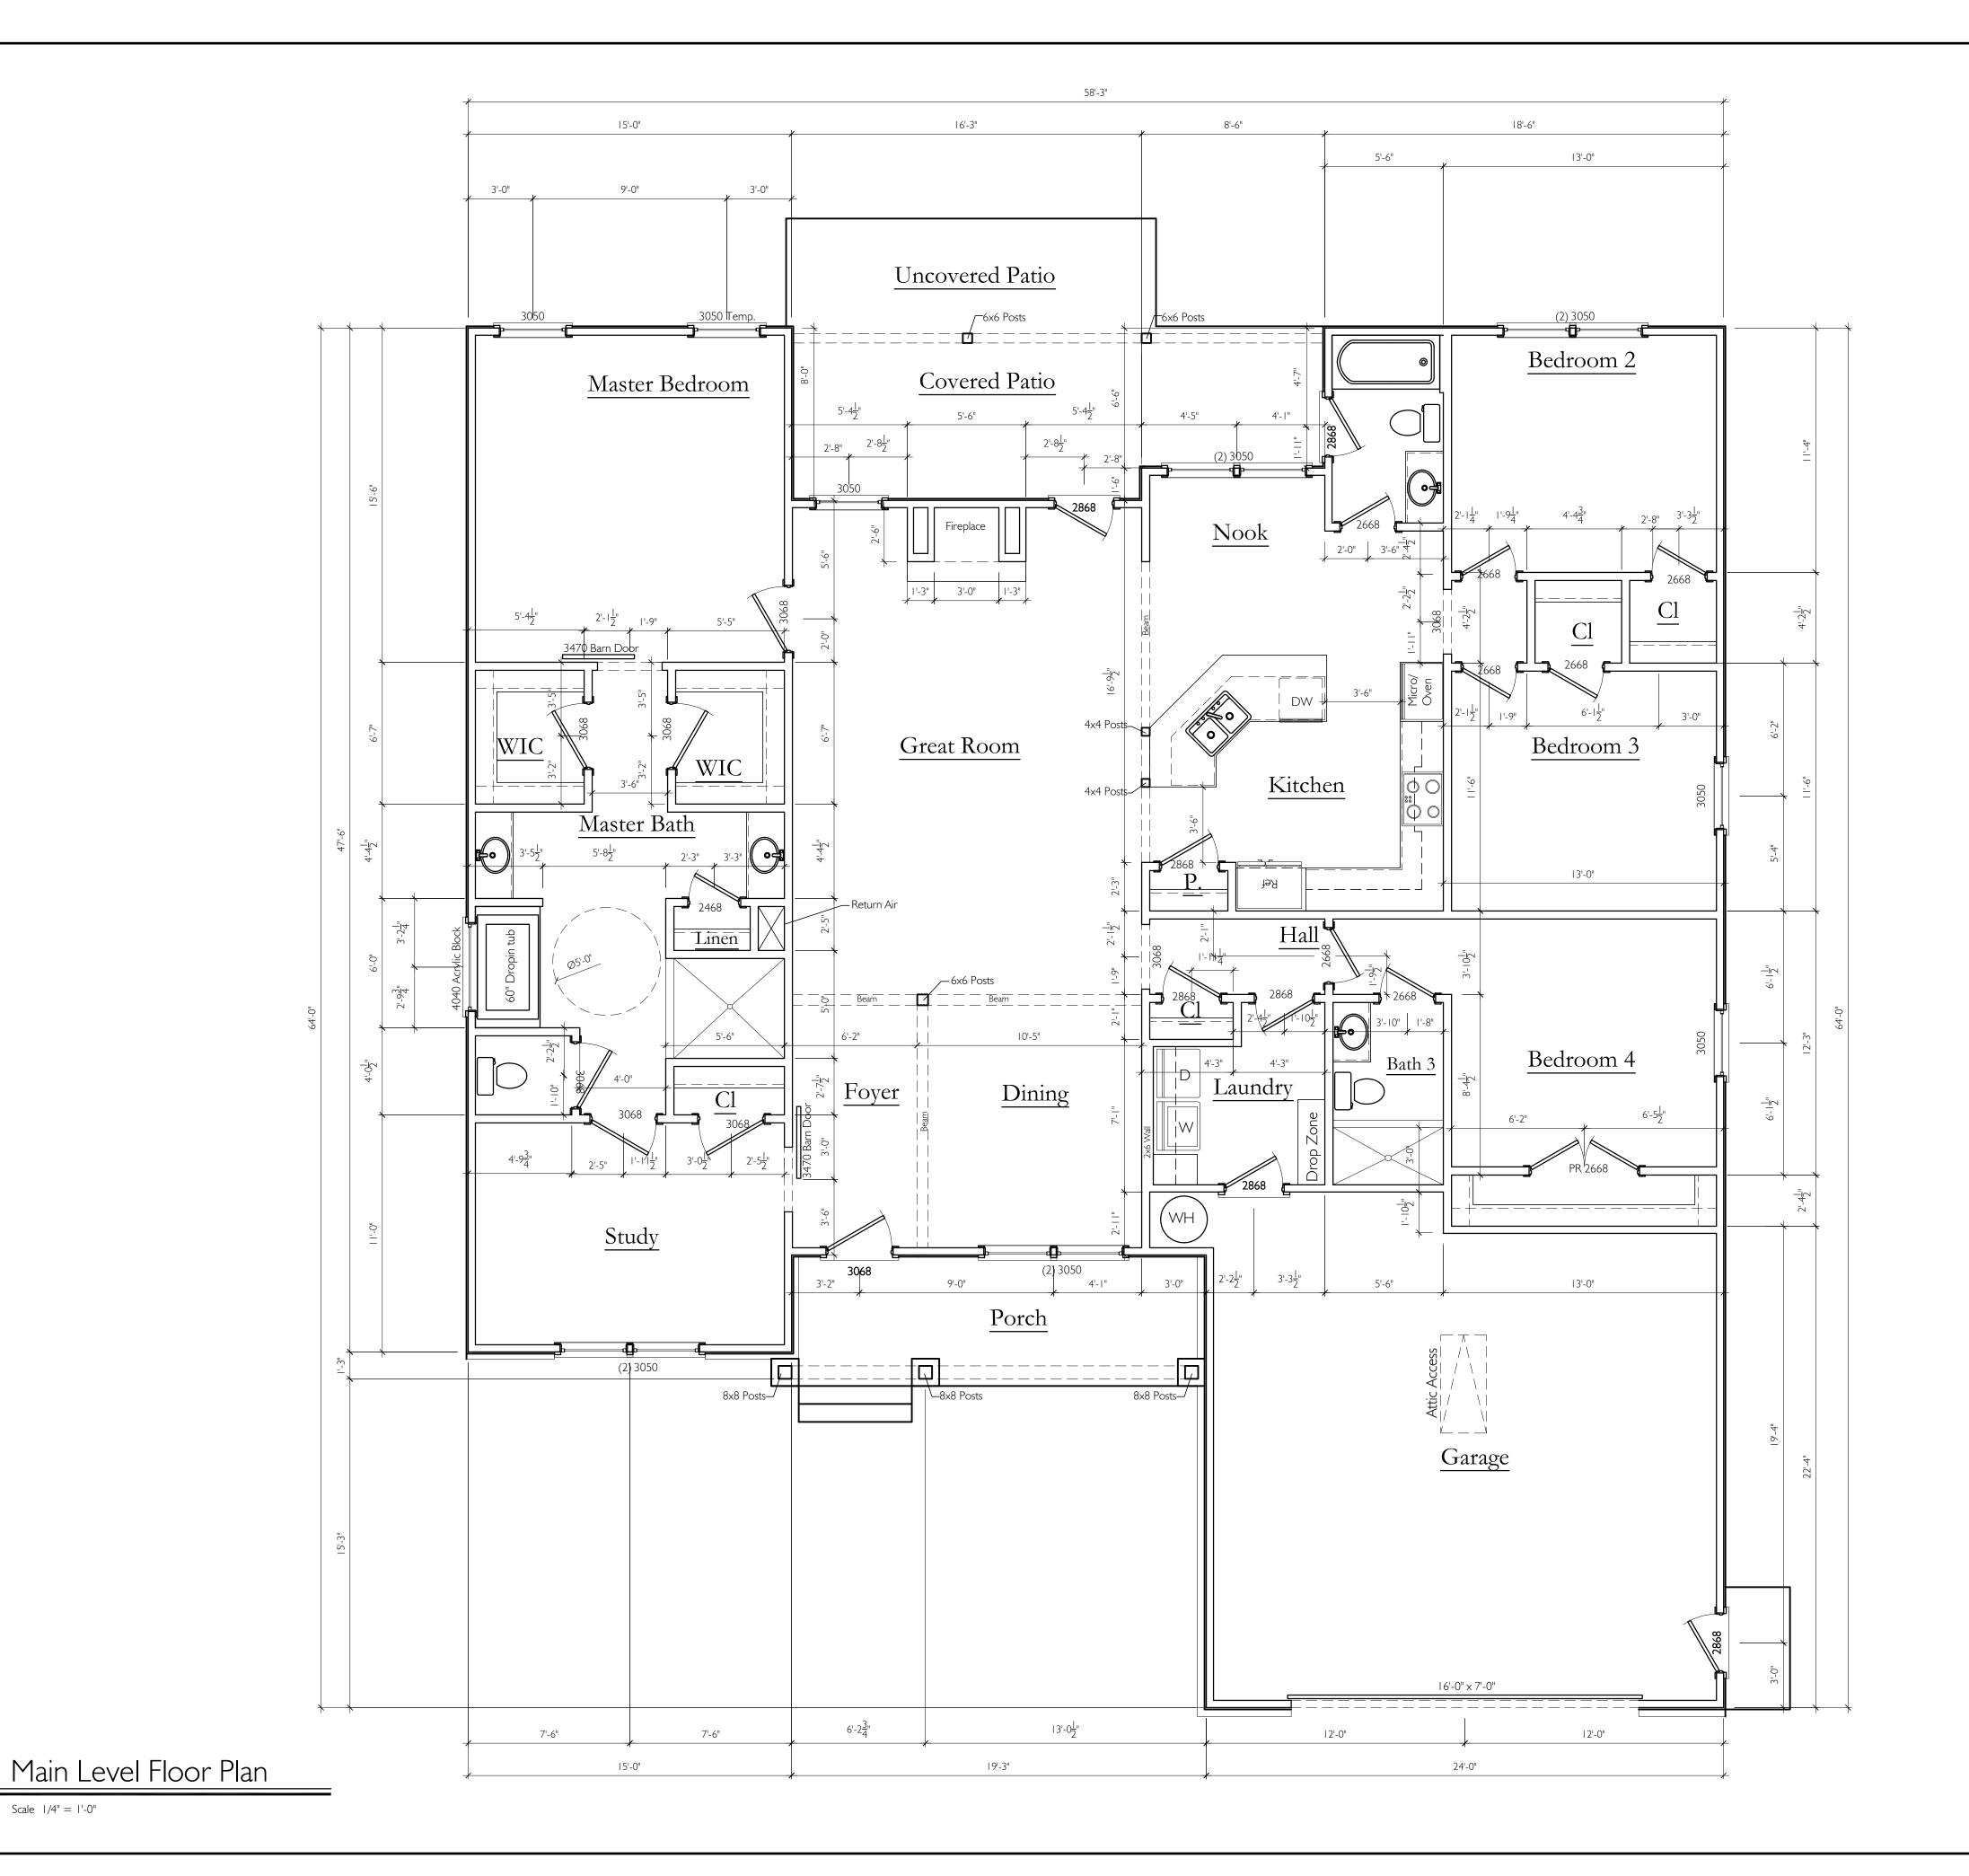
Front Porch Covered Patio Uncovered Patio

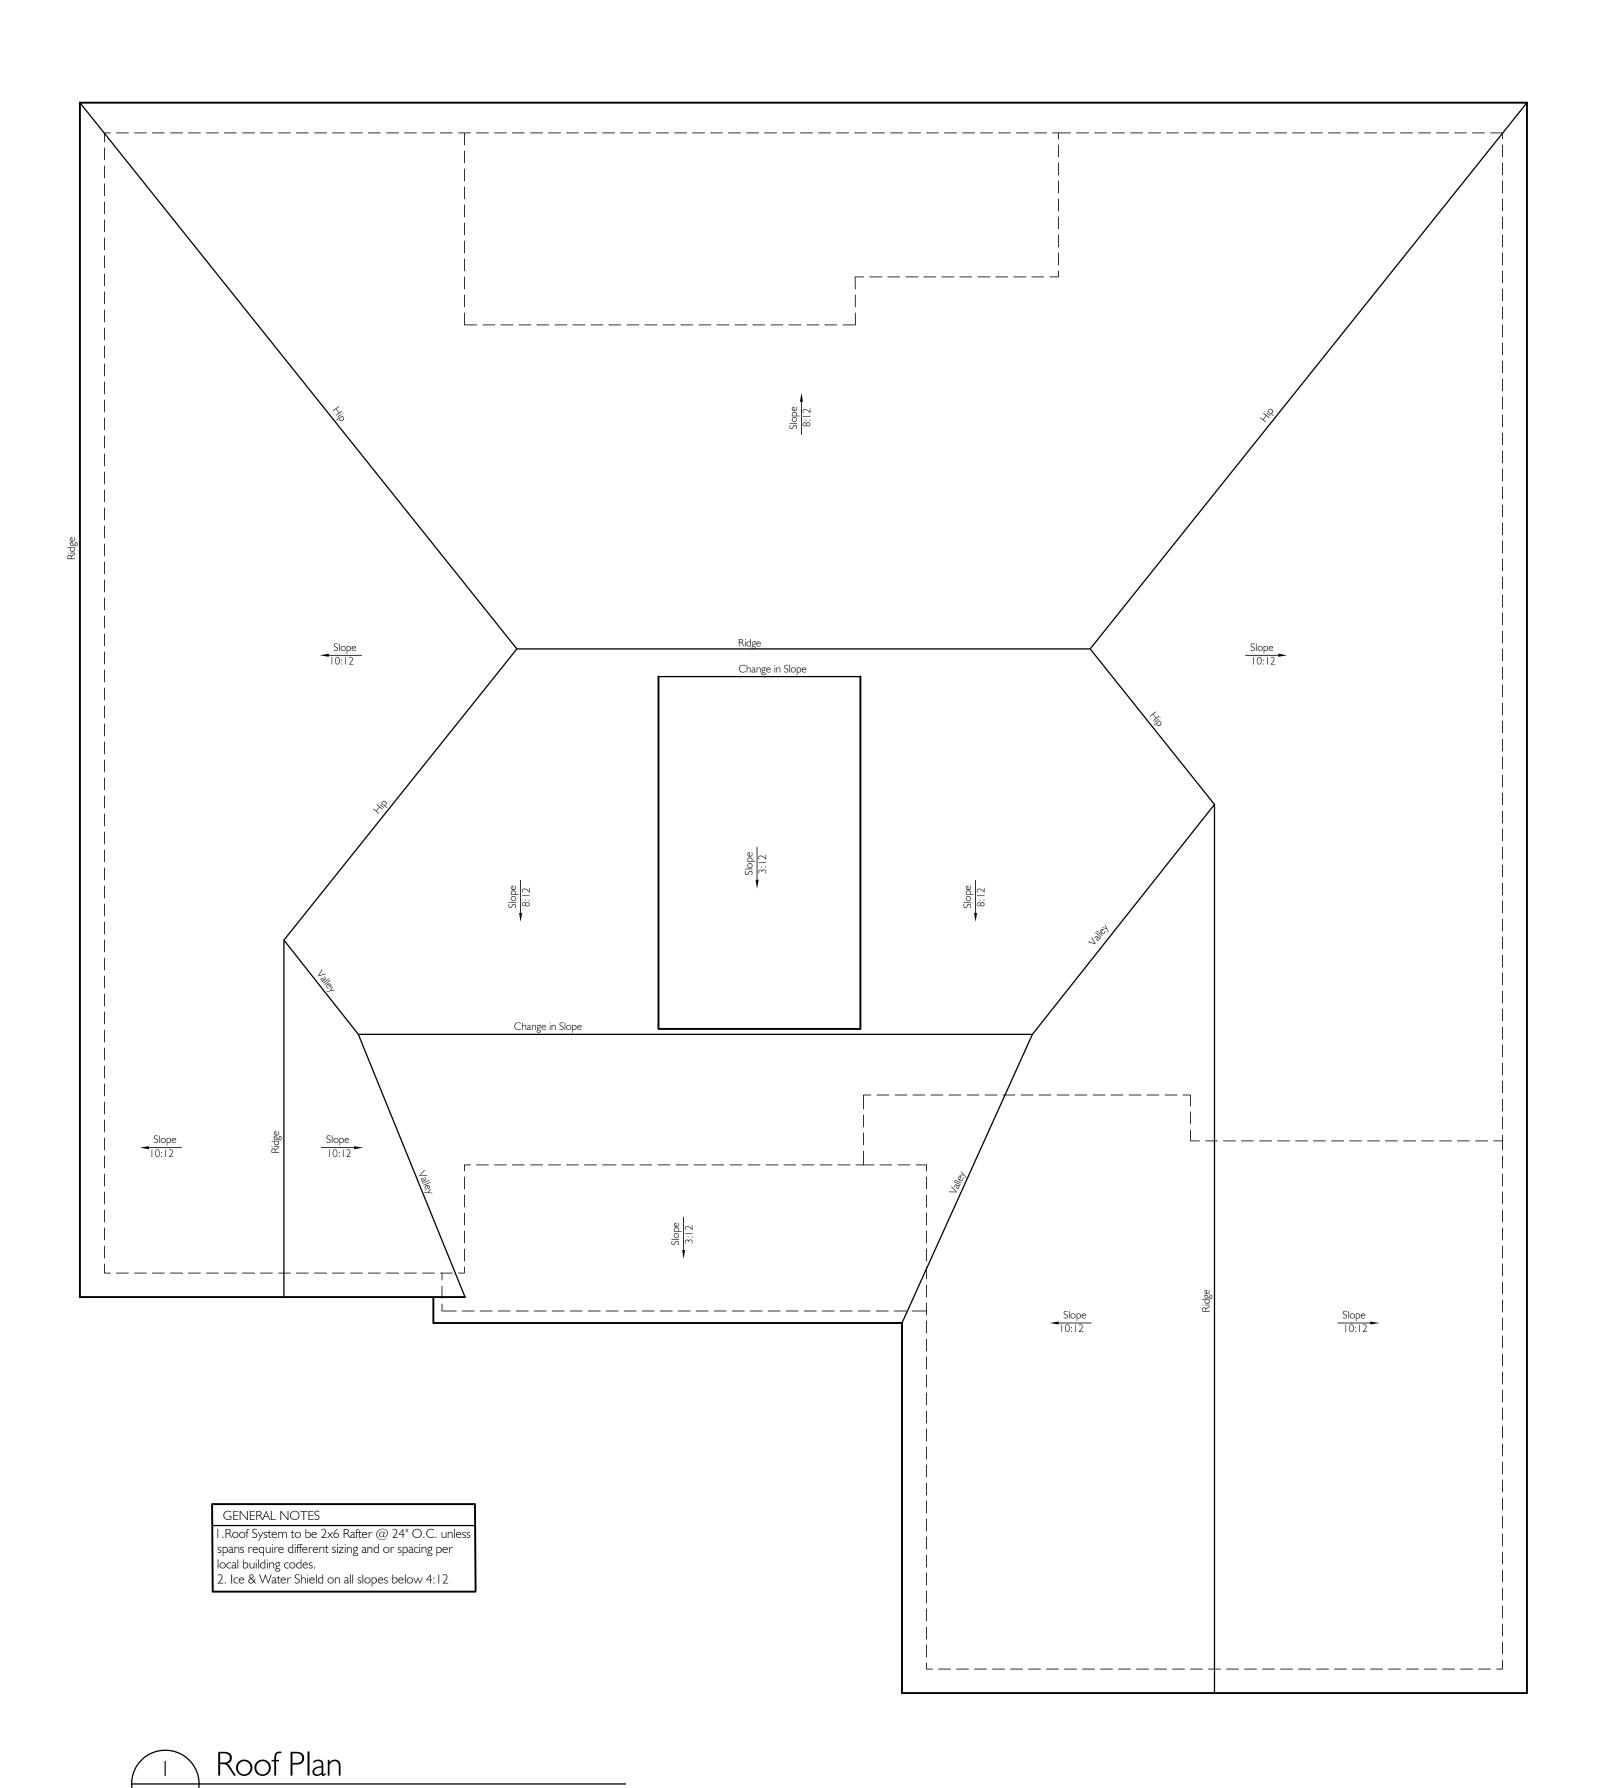555 SQ. FT. Garage

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SHEET NUMBER Roof Plan



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S. Q. FOOTAGES

Main Level

2330 SQ. FT.

Front Porch Covered Patio Uncovered Patio

Garage


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E1.0 Main Level Electrical Plan
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SHEET NUMBER Main Floor Plan



MATERIALS LEGEND Brick Veneer; 2 Lap Siding 7 1/4" Hardi 3 5 1/4" x6" Trim Board Hardi 4 Architectural Asphalt Shingle;

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MASON

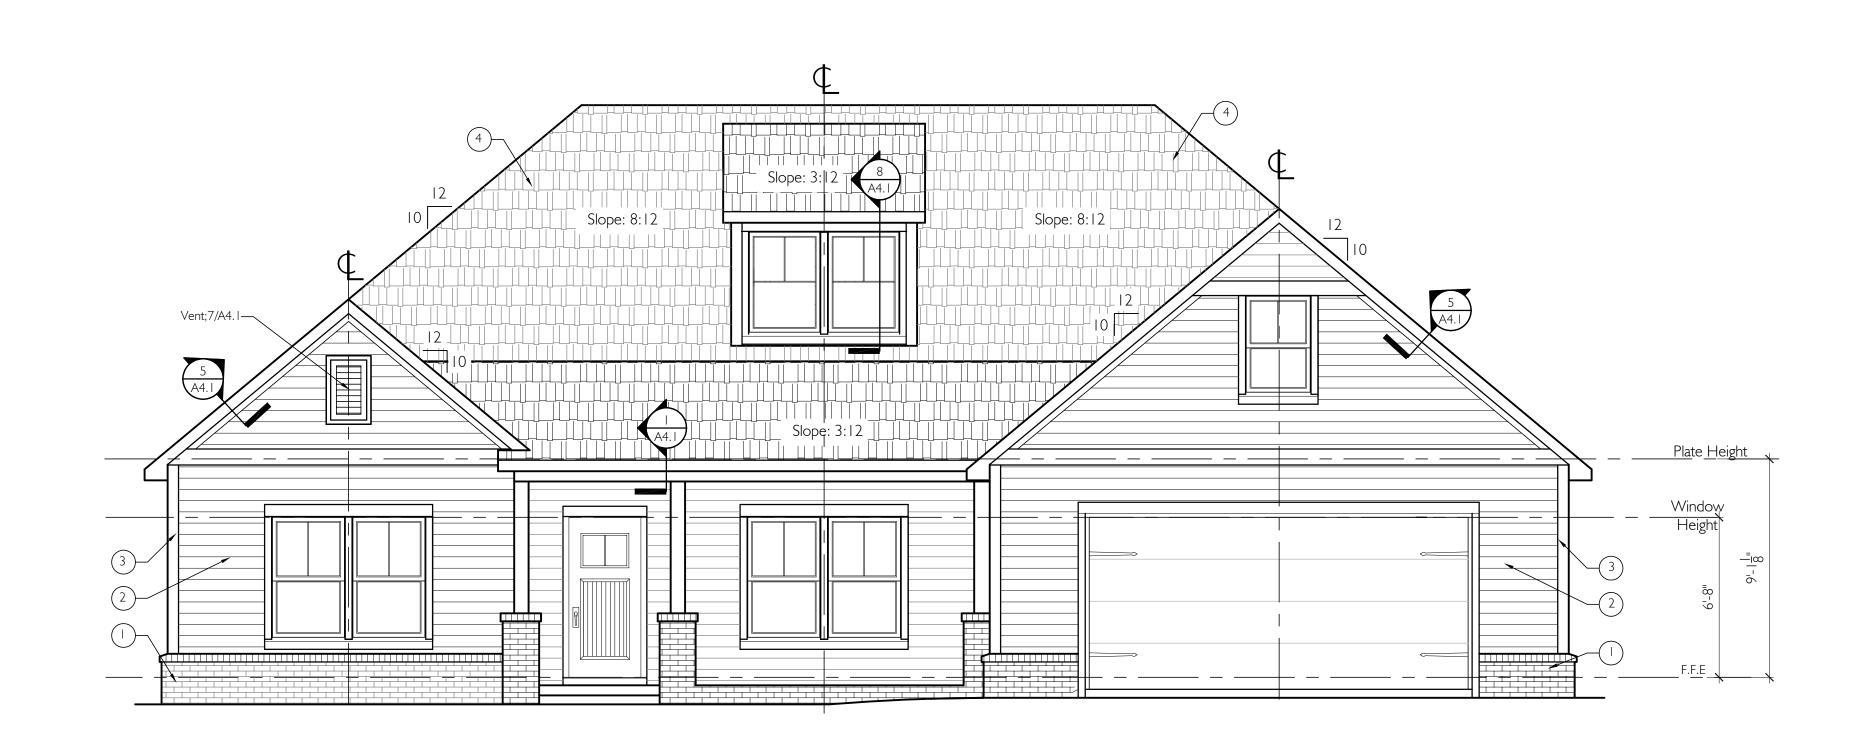

Plan Schedule Revisions: 03-12-2019 Floor Plan Review Bid Set Full CD's Final Drawings

S.Q. FOOTAGES

Main Level

2330 SQ. FT.


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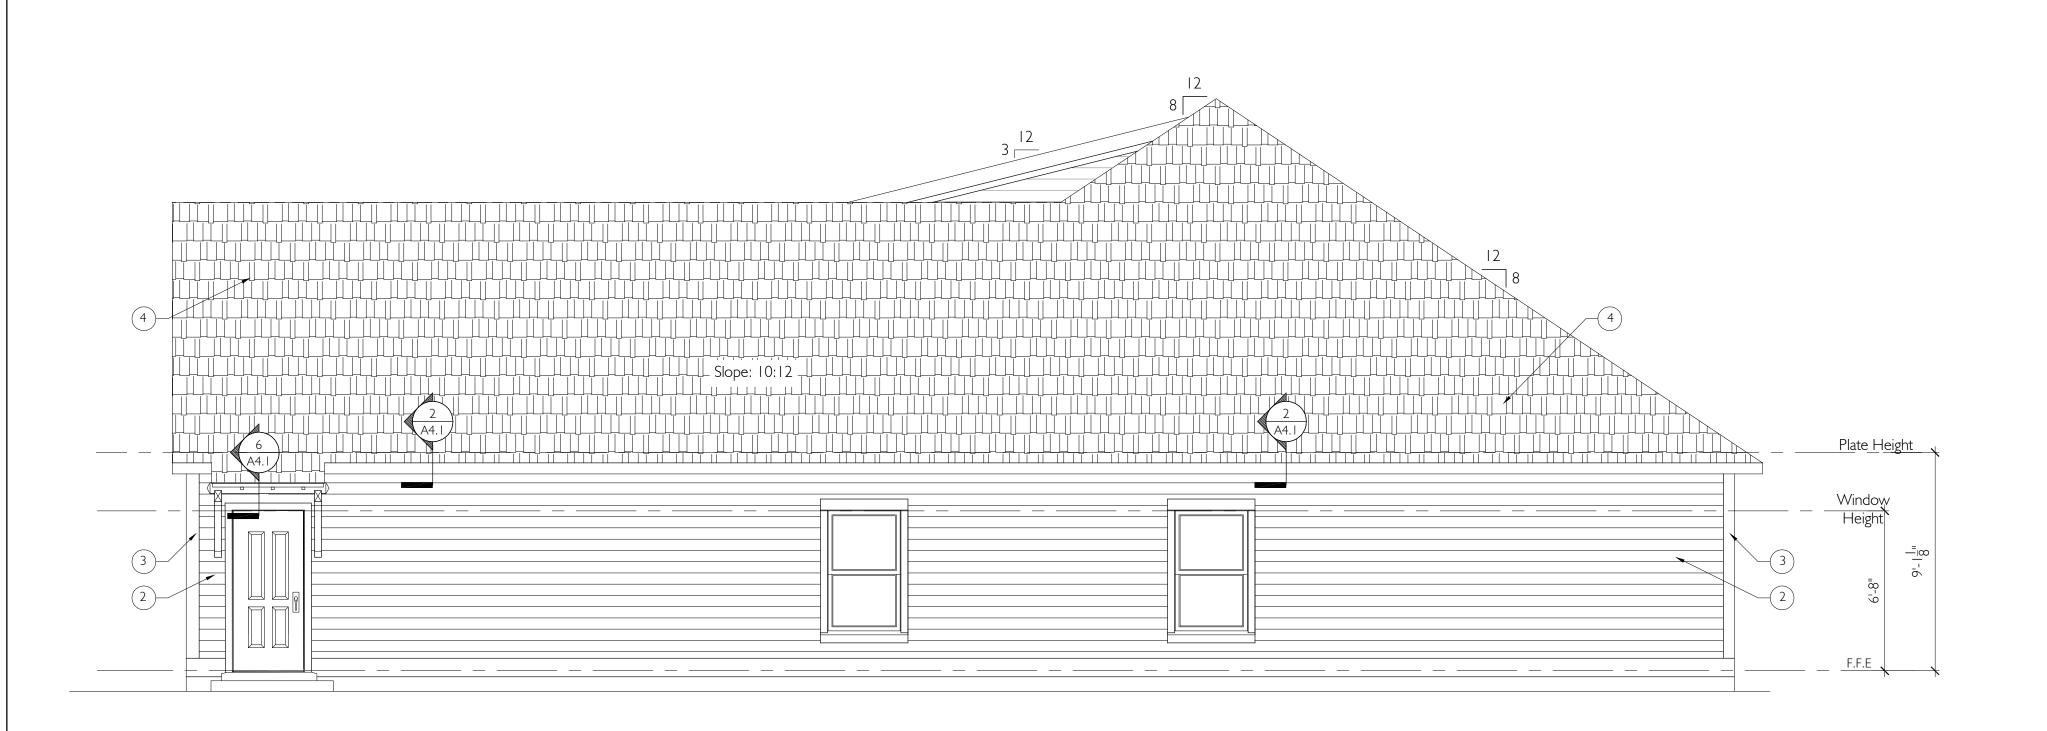
SHEET NUMBER
Exterior Elevations




Front Elevation

Rear Elevation

Scale 1/4" = 1'-0"

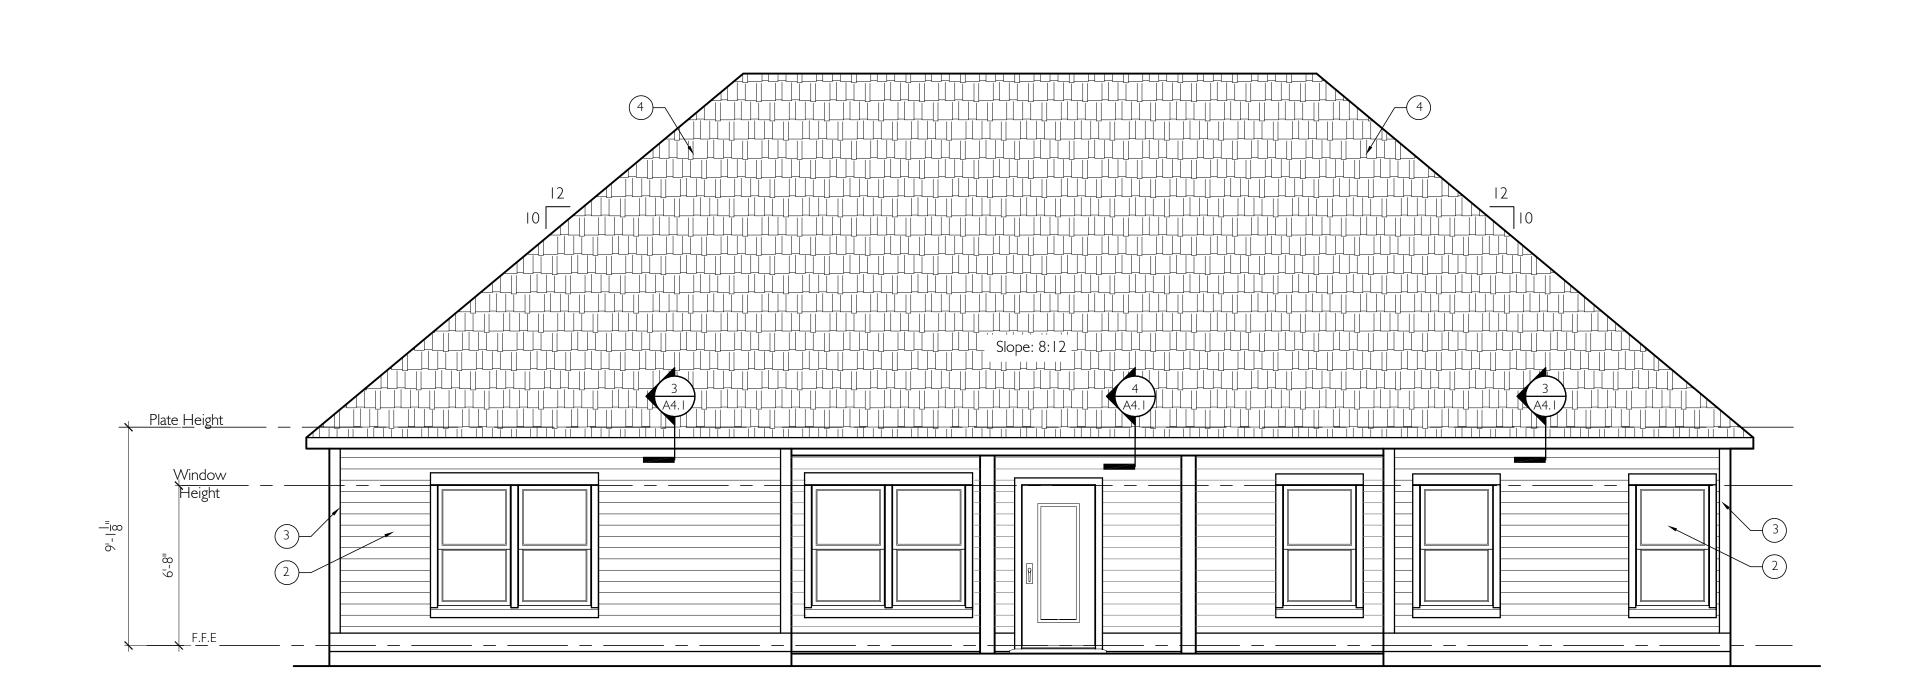

Left Elevation

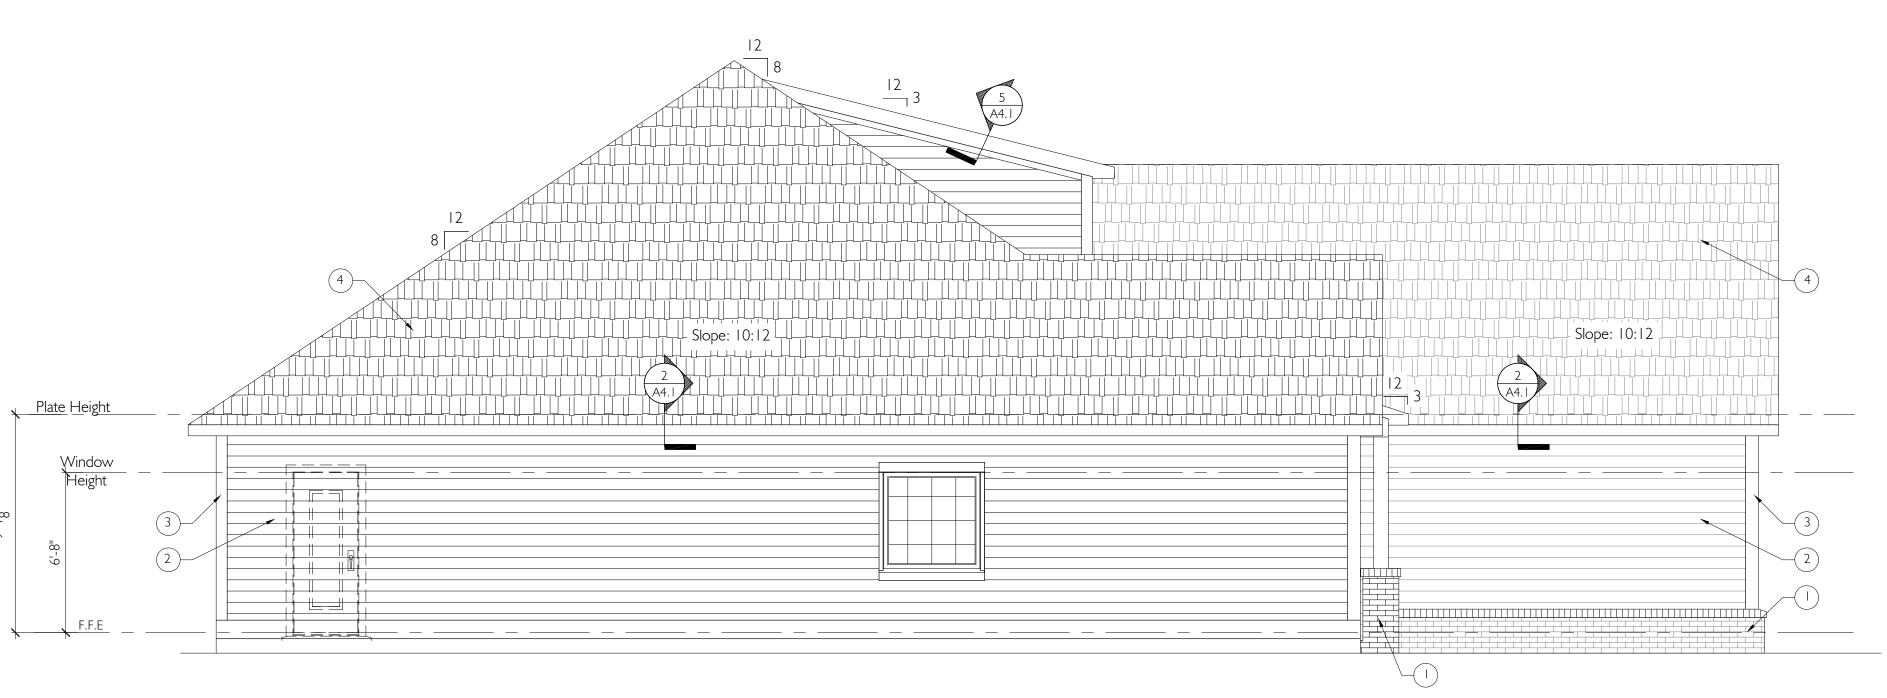

Right Elevation A3.1 Scale 1/4" = 1'-0"

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MATERIALS LEGEND

2 Lap Siding 7 1/4" Hardi

3 5 1/4" x6" Trim Board Hardi

4 Architectural Asphalt Shingle;

Brick Veneer;

HOMES

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S.Q. FOOTAGES

Main Level

2330 SQ. FT.

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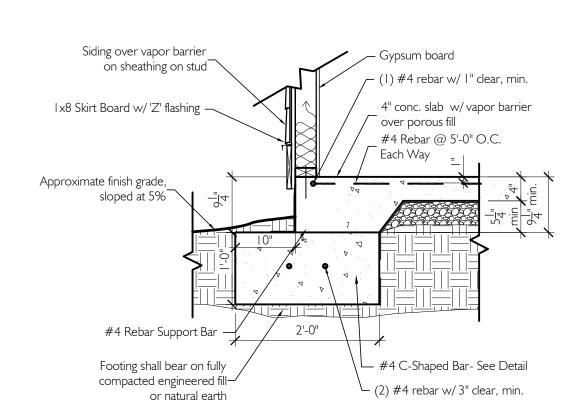
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Garage 555 SQ. FT.


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SHEET NUMBER Exterior Elevations




Foundation Detail at House




Foundation @ House with Brick

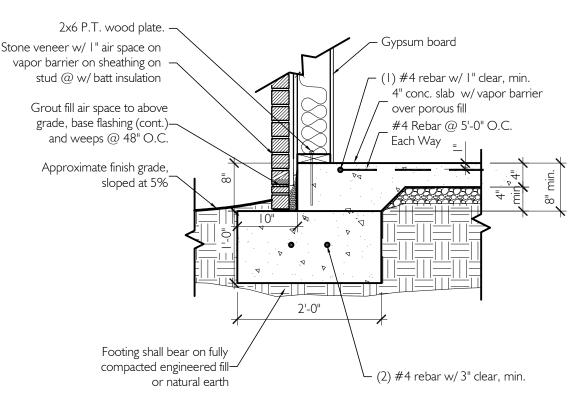
Siding over vapor barrier on sheathing on stud

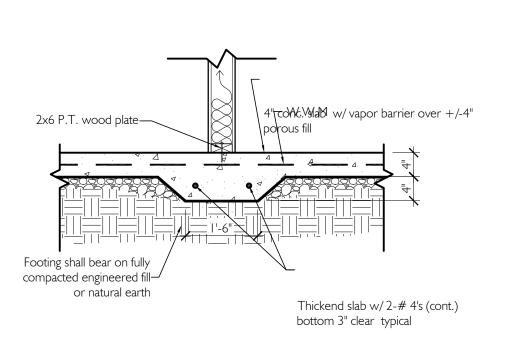


Detail @ Thickened Slab For Bearing \A4.0/

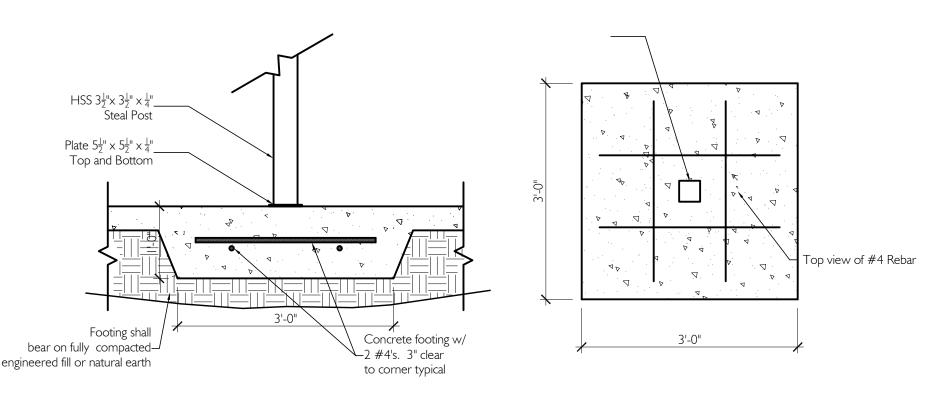

Column footing detail $\langle A4.0 \rangle$

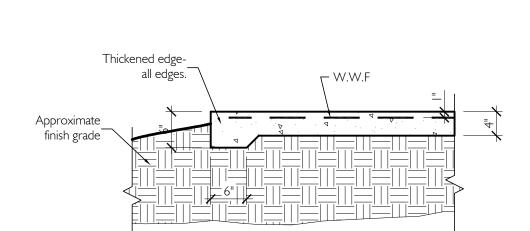


Detail at Non-bearing Patio Slab

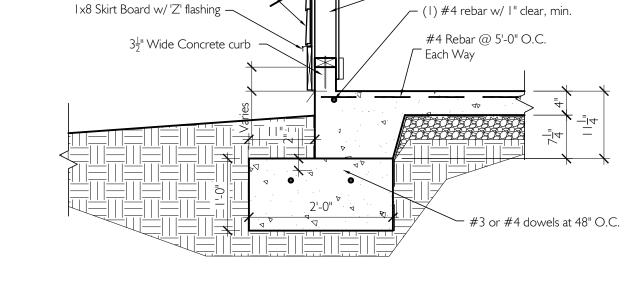


2x4 Stud Wall without

Foundation at Garage with Siding

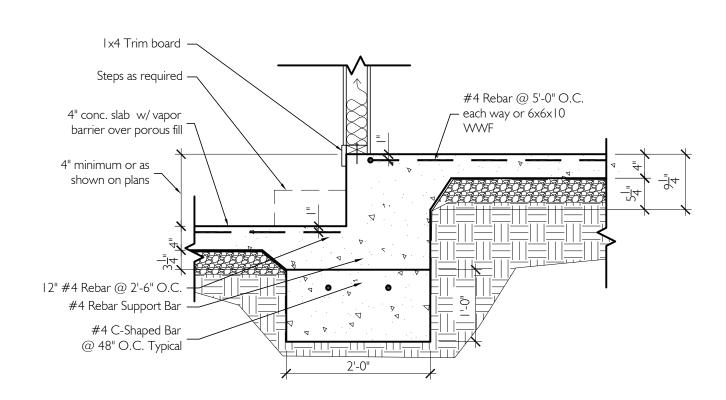

Foundation Detail at Gar./House

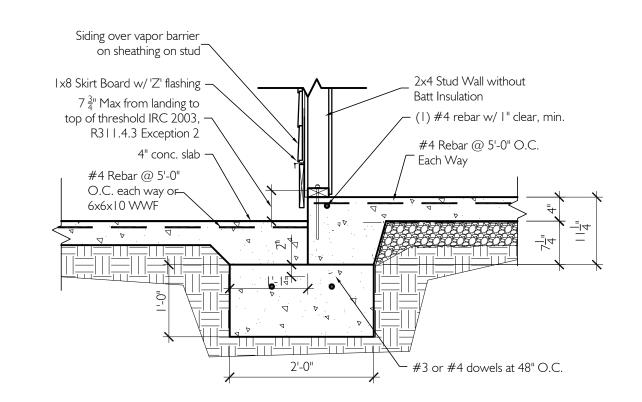

Foundation Detail at Porch w/ Siding A4.0

#4 Rebar @ 5'-0" O.C. Slope $\frac{1}{8}$ " per foot toward exterior – each way or 6x6x10 Approximate finish grade, 2'-0" Footing shall bear on fully or natural earth

I. All foundation detail to be designed by others.

Details provided in this set of plans are for general

2. Water proofing & flashing to be installed at all

areas that are exposed to the elements or soil.


3. Expansion, construction joints, membrane &

water stop to be install per specification

General Notes:

information.

Foundation Detail at Garage Opening

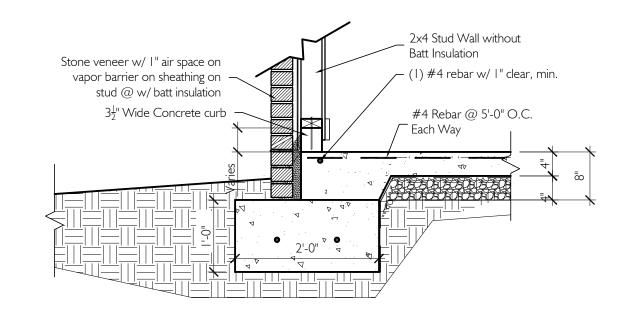

Foundation at Garage with Stone


BRACED WALL GENERAL NOTES

EXTERIOR


- THE EXTERIOR WALLS SHALL BE CONTINUOUSLY SHEATHED WITH 1/2 " OB WITH WOOD BLOCKING PROVIDED AT PANEL SPLICES
- THE OSB SHALL BE CONNECTED TO THE WOOD FRAMING WITH 8D COMMON NAILS (6" AT EDGES, 12 IN FIELD)
- THE EXTERIOR WALLS SHALL HAVE 1/2" GYPSUM ON THE INTERIOR FACE OF THE WOOD FRAMING ATTACHED WITH SCREWS (7" AT EDGES, 16" IN FIELD)

INTERIOR

- INTERIOR BRACED WALLS ARE TO BE ANCHORED TO THE SLAB ALONG THE ENTIRE LENGTH OF THE BRACED WALL LINE AT 6" oc WITH 1/2" **DIAMETER WEDGE ANCHORS WITH 3"** CONCRETE EMBEDMENT
- INTERIOR BRACED WALL PANELS SHALL BE CONNECTED TO THE FRAMING FOR THE MINIMUM REQUIRED LENGTH.
- INTERIOR WALLS SHALL HAVE 1/2" GYPSUM (MINIMUM) ON BOTH FACES OF THE WOOD FRAMING ATTACHED WITH SCREWS (7" AT EDGES, 16" IN FIELD) WITH WOOD **BLOCKING PROVIDED AT PANEL** SPLICES.

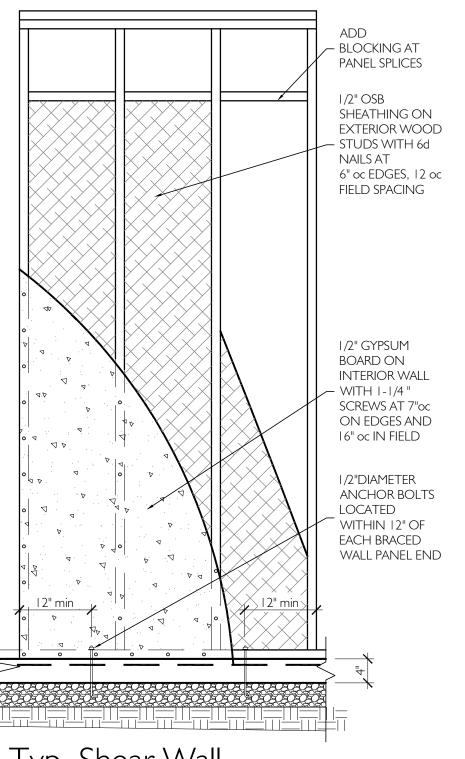

Typ. Shear Wall Continuous OSB Sheathing

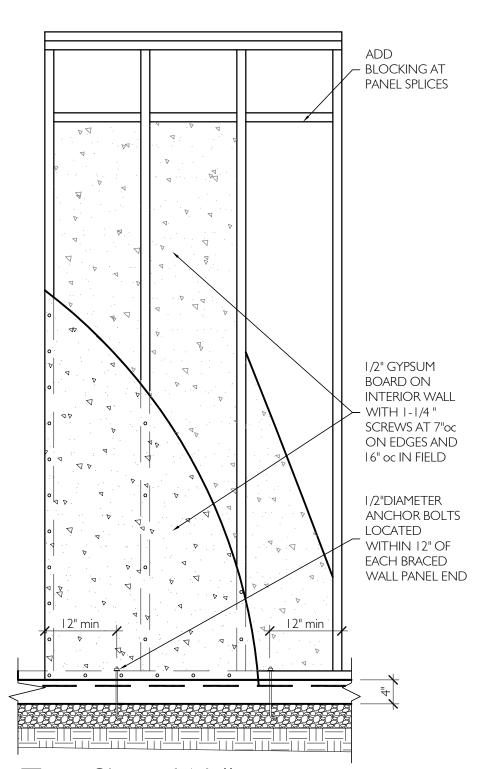

Typ. Shear Wall Continuous Gypsum Board

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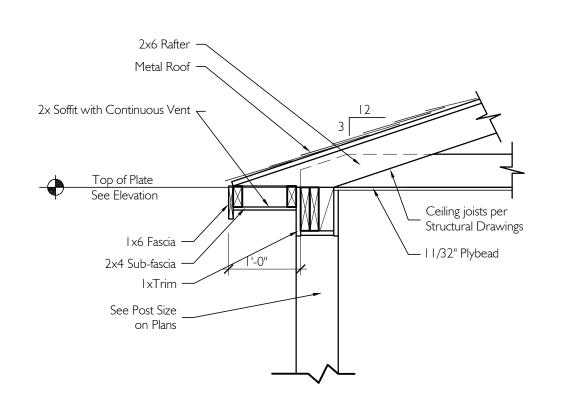
A4.1 Standard Framing Details A4.2 Framing Details


E1.0 Main Level Electrical Plan


E1.1 Upper Level Electrical Plan


SHEET NUMBER Foundation Details

A4.0



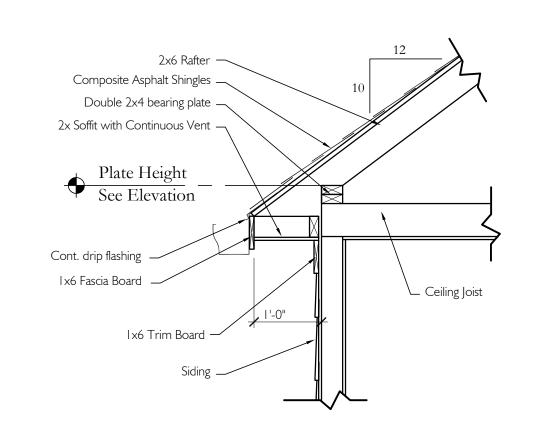

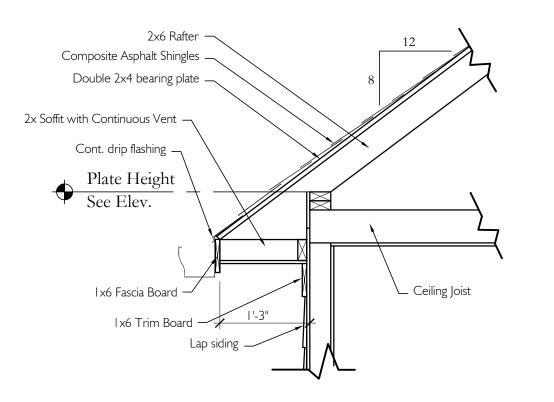

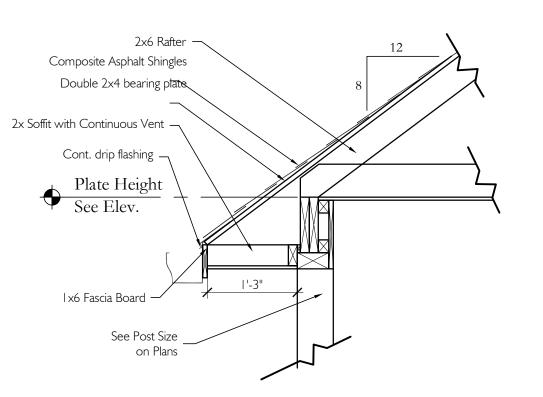



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Eave Detail

Eave Detail


Eave Detail


Eave Detail


15# Felt on decking -


2x6 rafters —

Cont. Metal Flashing —

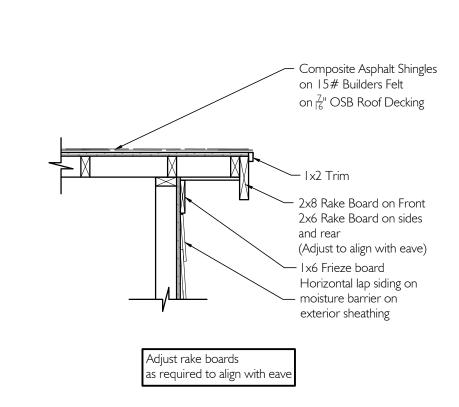

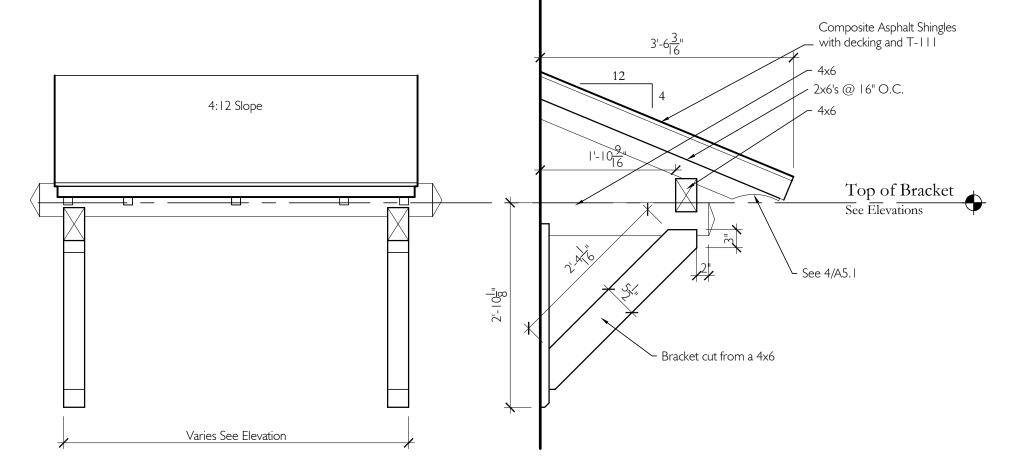

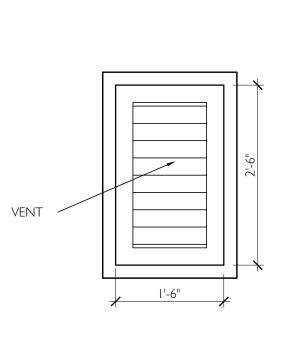

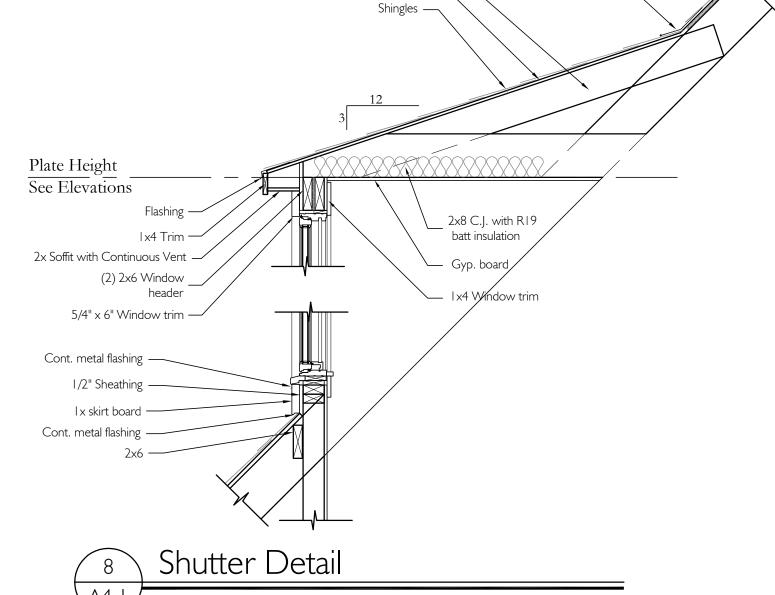

Rake Detail

Shed Roof

Vent Detail

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1 Garage

Main Level

Front Porch

Covered Patio Uncovered Patio

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E1.0 Main Level Electrical Plan E1.1 Upper Level Electrical Plan


SHEET NUMBER A4.1


Notes:

1. Overhang widths will very in order to line up with different sloped overhangs and rakes

2. Details on this page are for general construction use only and may very depending on the width, bearing height & if it is a main level or upper level detail. Field verify all details before construction with window placement.

3. These details are designed for stick framing and not trusses.

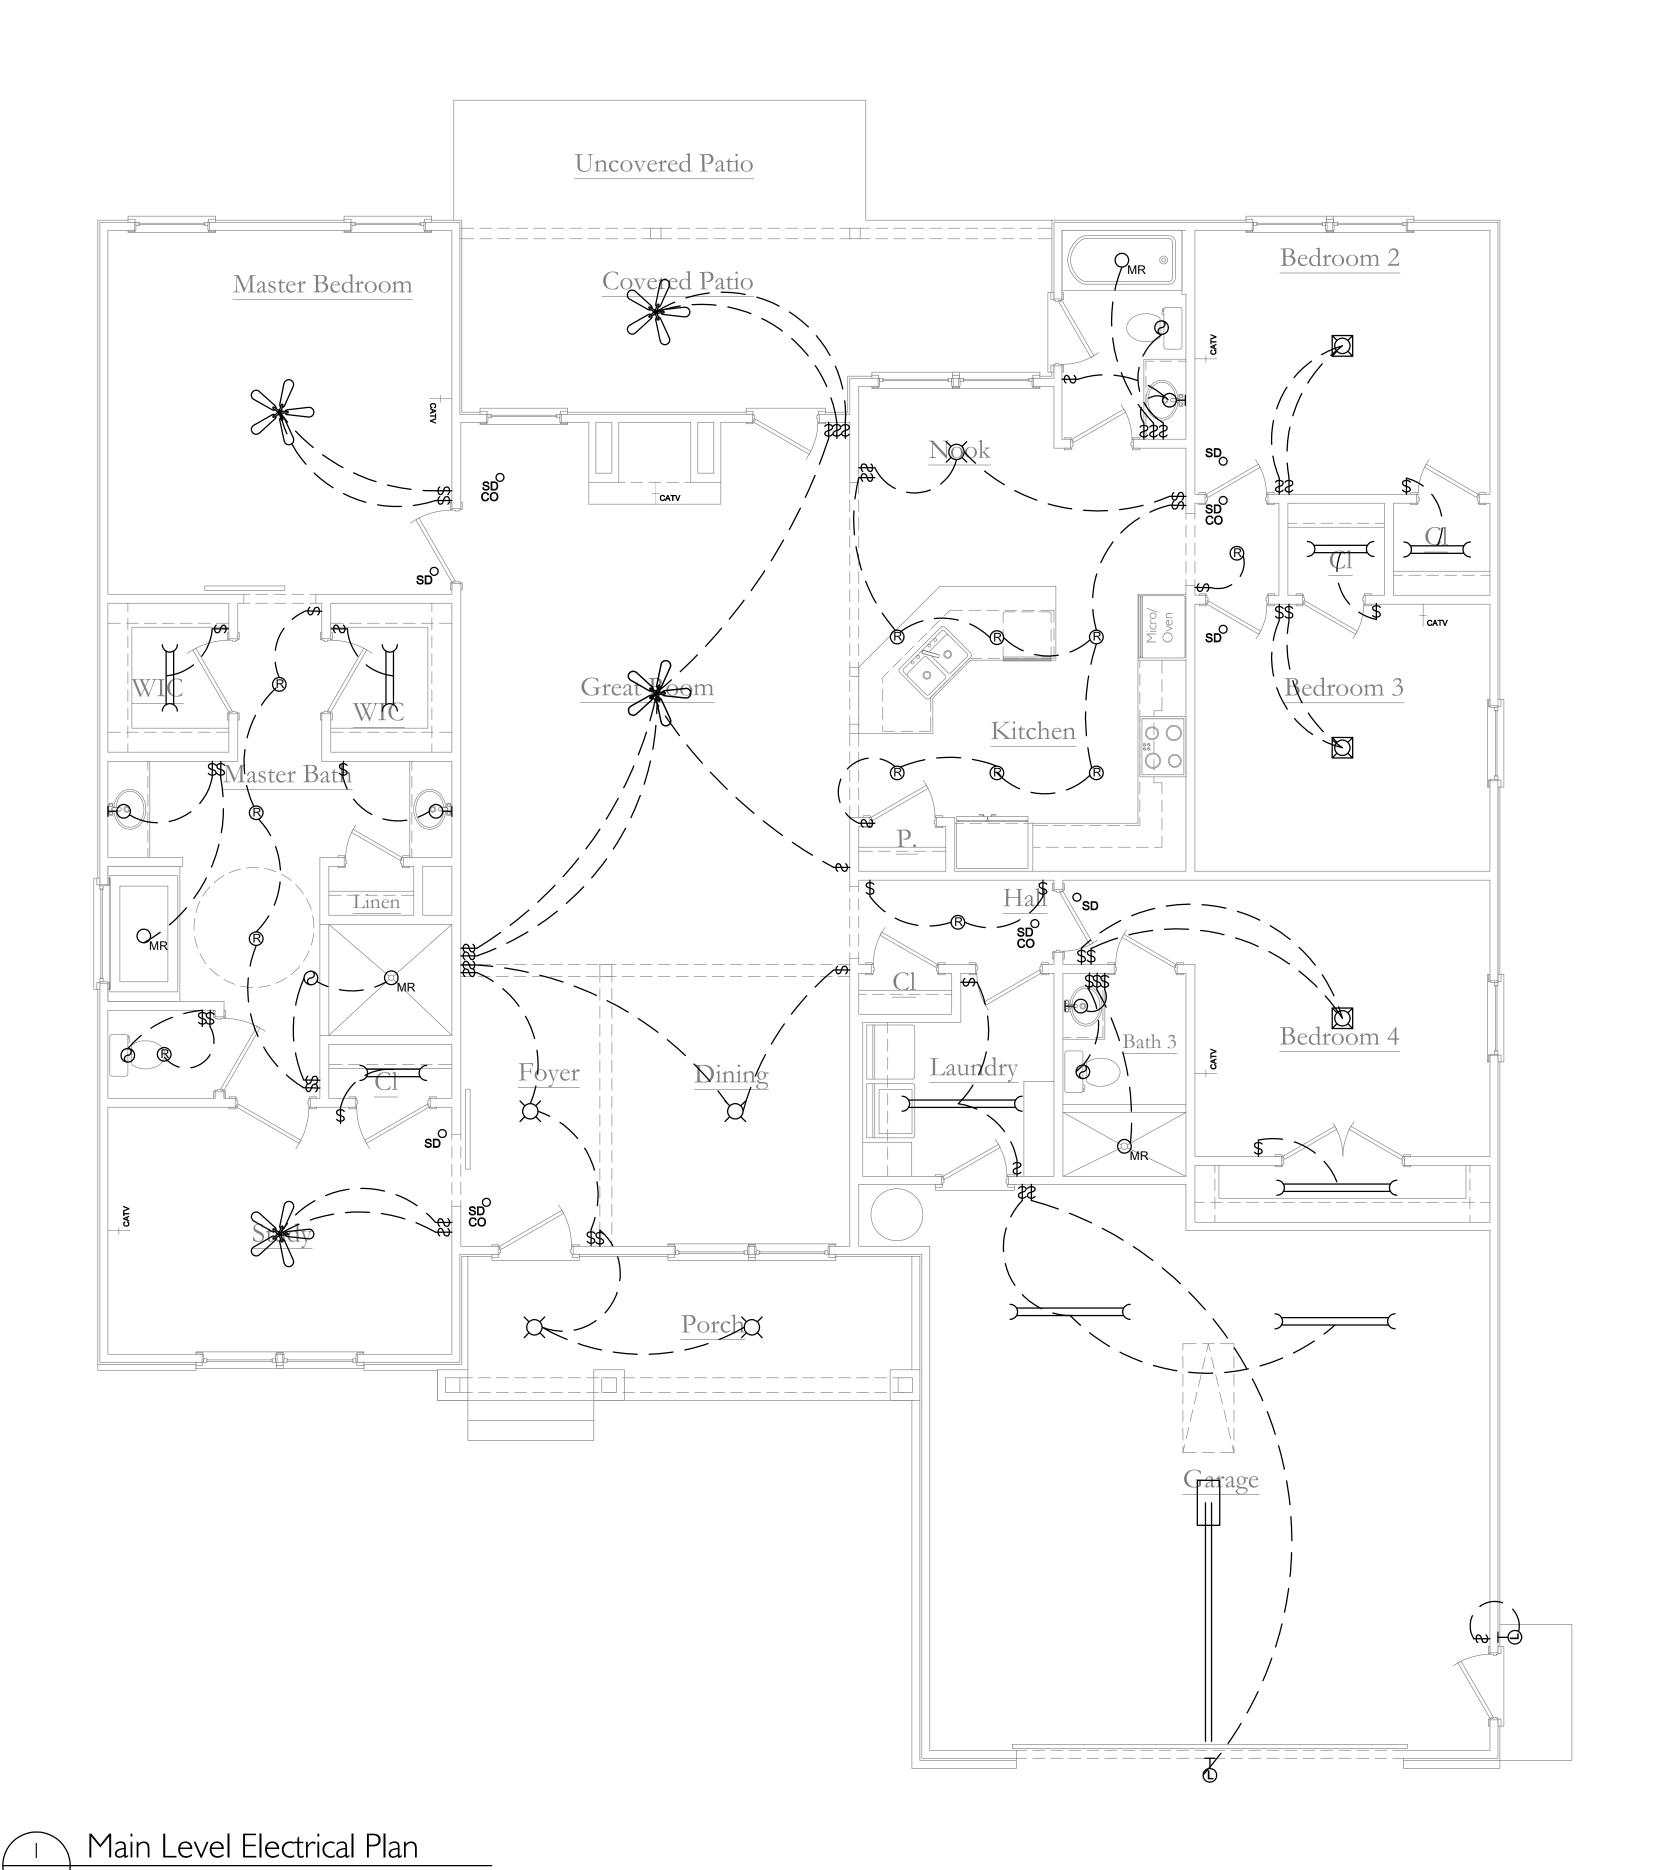

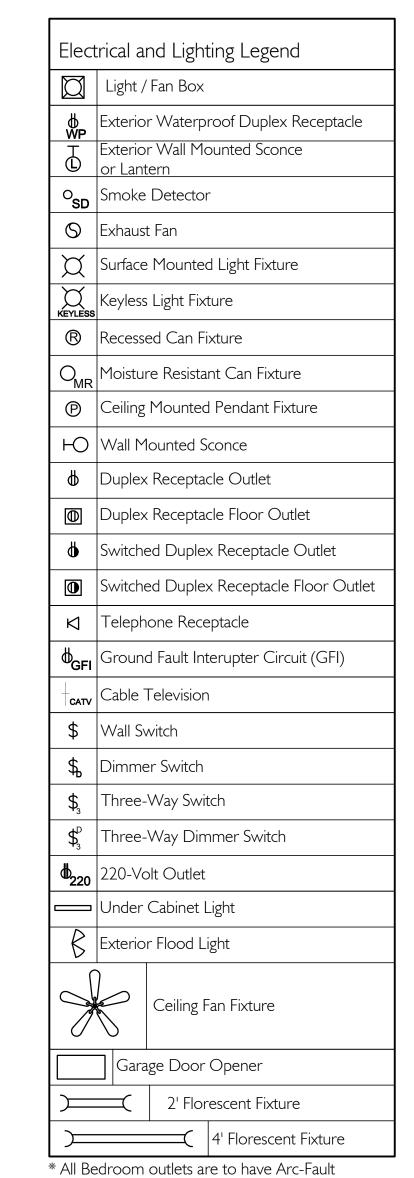

Circuit-Interrupter Protection as specified in the 2002 NEC * All outlets to be installed per governing code where the project is being built * Provide smoke detectors in each bedroom and in the immediate area (10'-0") outside the bedroom

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SHEET NUMBER

Main Level

Electrical Plan